

REVISIONS

2-29-20 REVISED SITE FOR NEW BUILDING

4


M M GR.


Seal Redacted 1940

CLOS PROPERTIES, LLC SHANE HEFFERNAN 255 OLD EASTWOOD ROAD WILMINGTON, NC 28403 (910) 202-4662

RAWN:	JAE	SHEET SIZE:	24 X 36
HECKED:	CDC	DATE:	9/8/2020
PPROVED:	CDC	SCALE:	1" = 40'
ROJECT NUMBER:		2019-027	

C-o

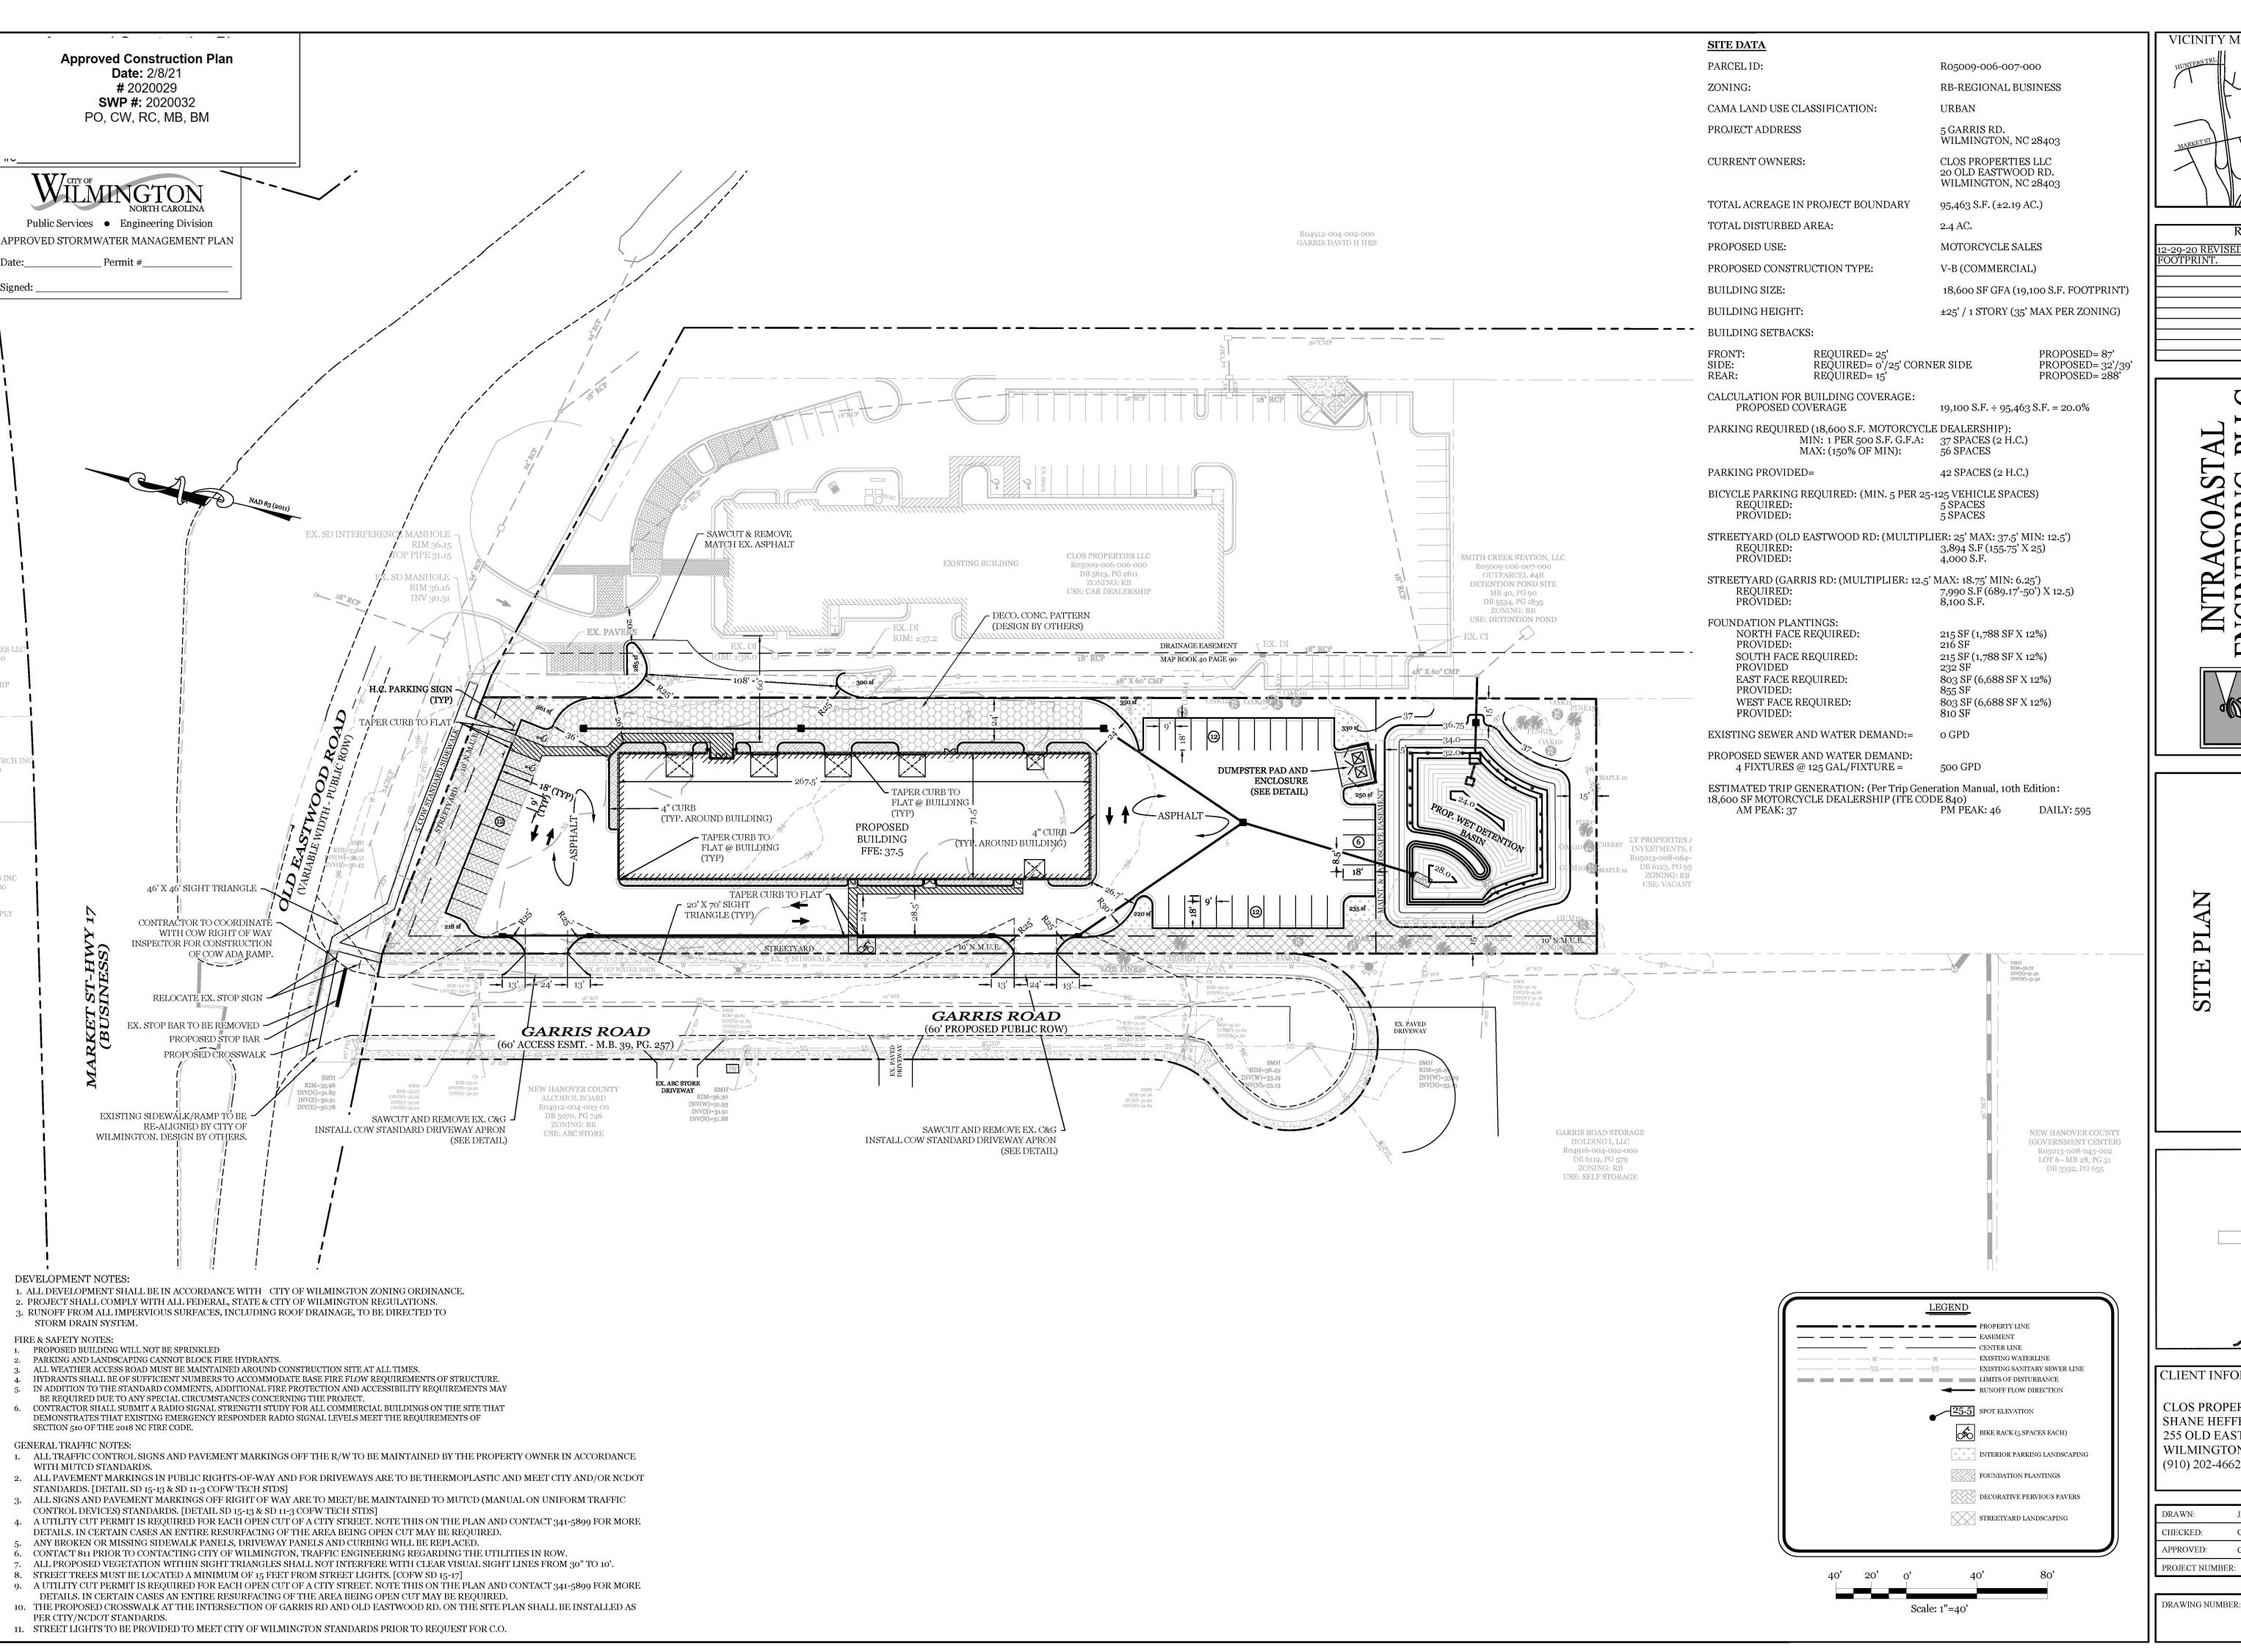


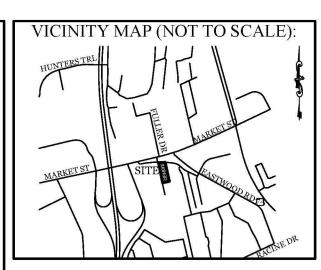

REVISIONS

2-29-20 REVISED SITE FOR NEW BUILDING

4

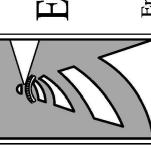



Seal Redacted 1900

CLIENT INFORMATION:

CLOS PROPERTIES, LLC SHANE HEFFERNAN 255 OLD EASTWOOD ROAD WILMINGTON, NC 28403 (910) 202-4662

RAWN:	JAE	SHEET SIZE:	24 X 36
HECKED:	CDC	DATE:	9/8/2020
PPROVED:	CDC	SCALE:	1" = 40'
ROJECT NUMBER:		2019-027	_

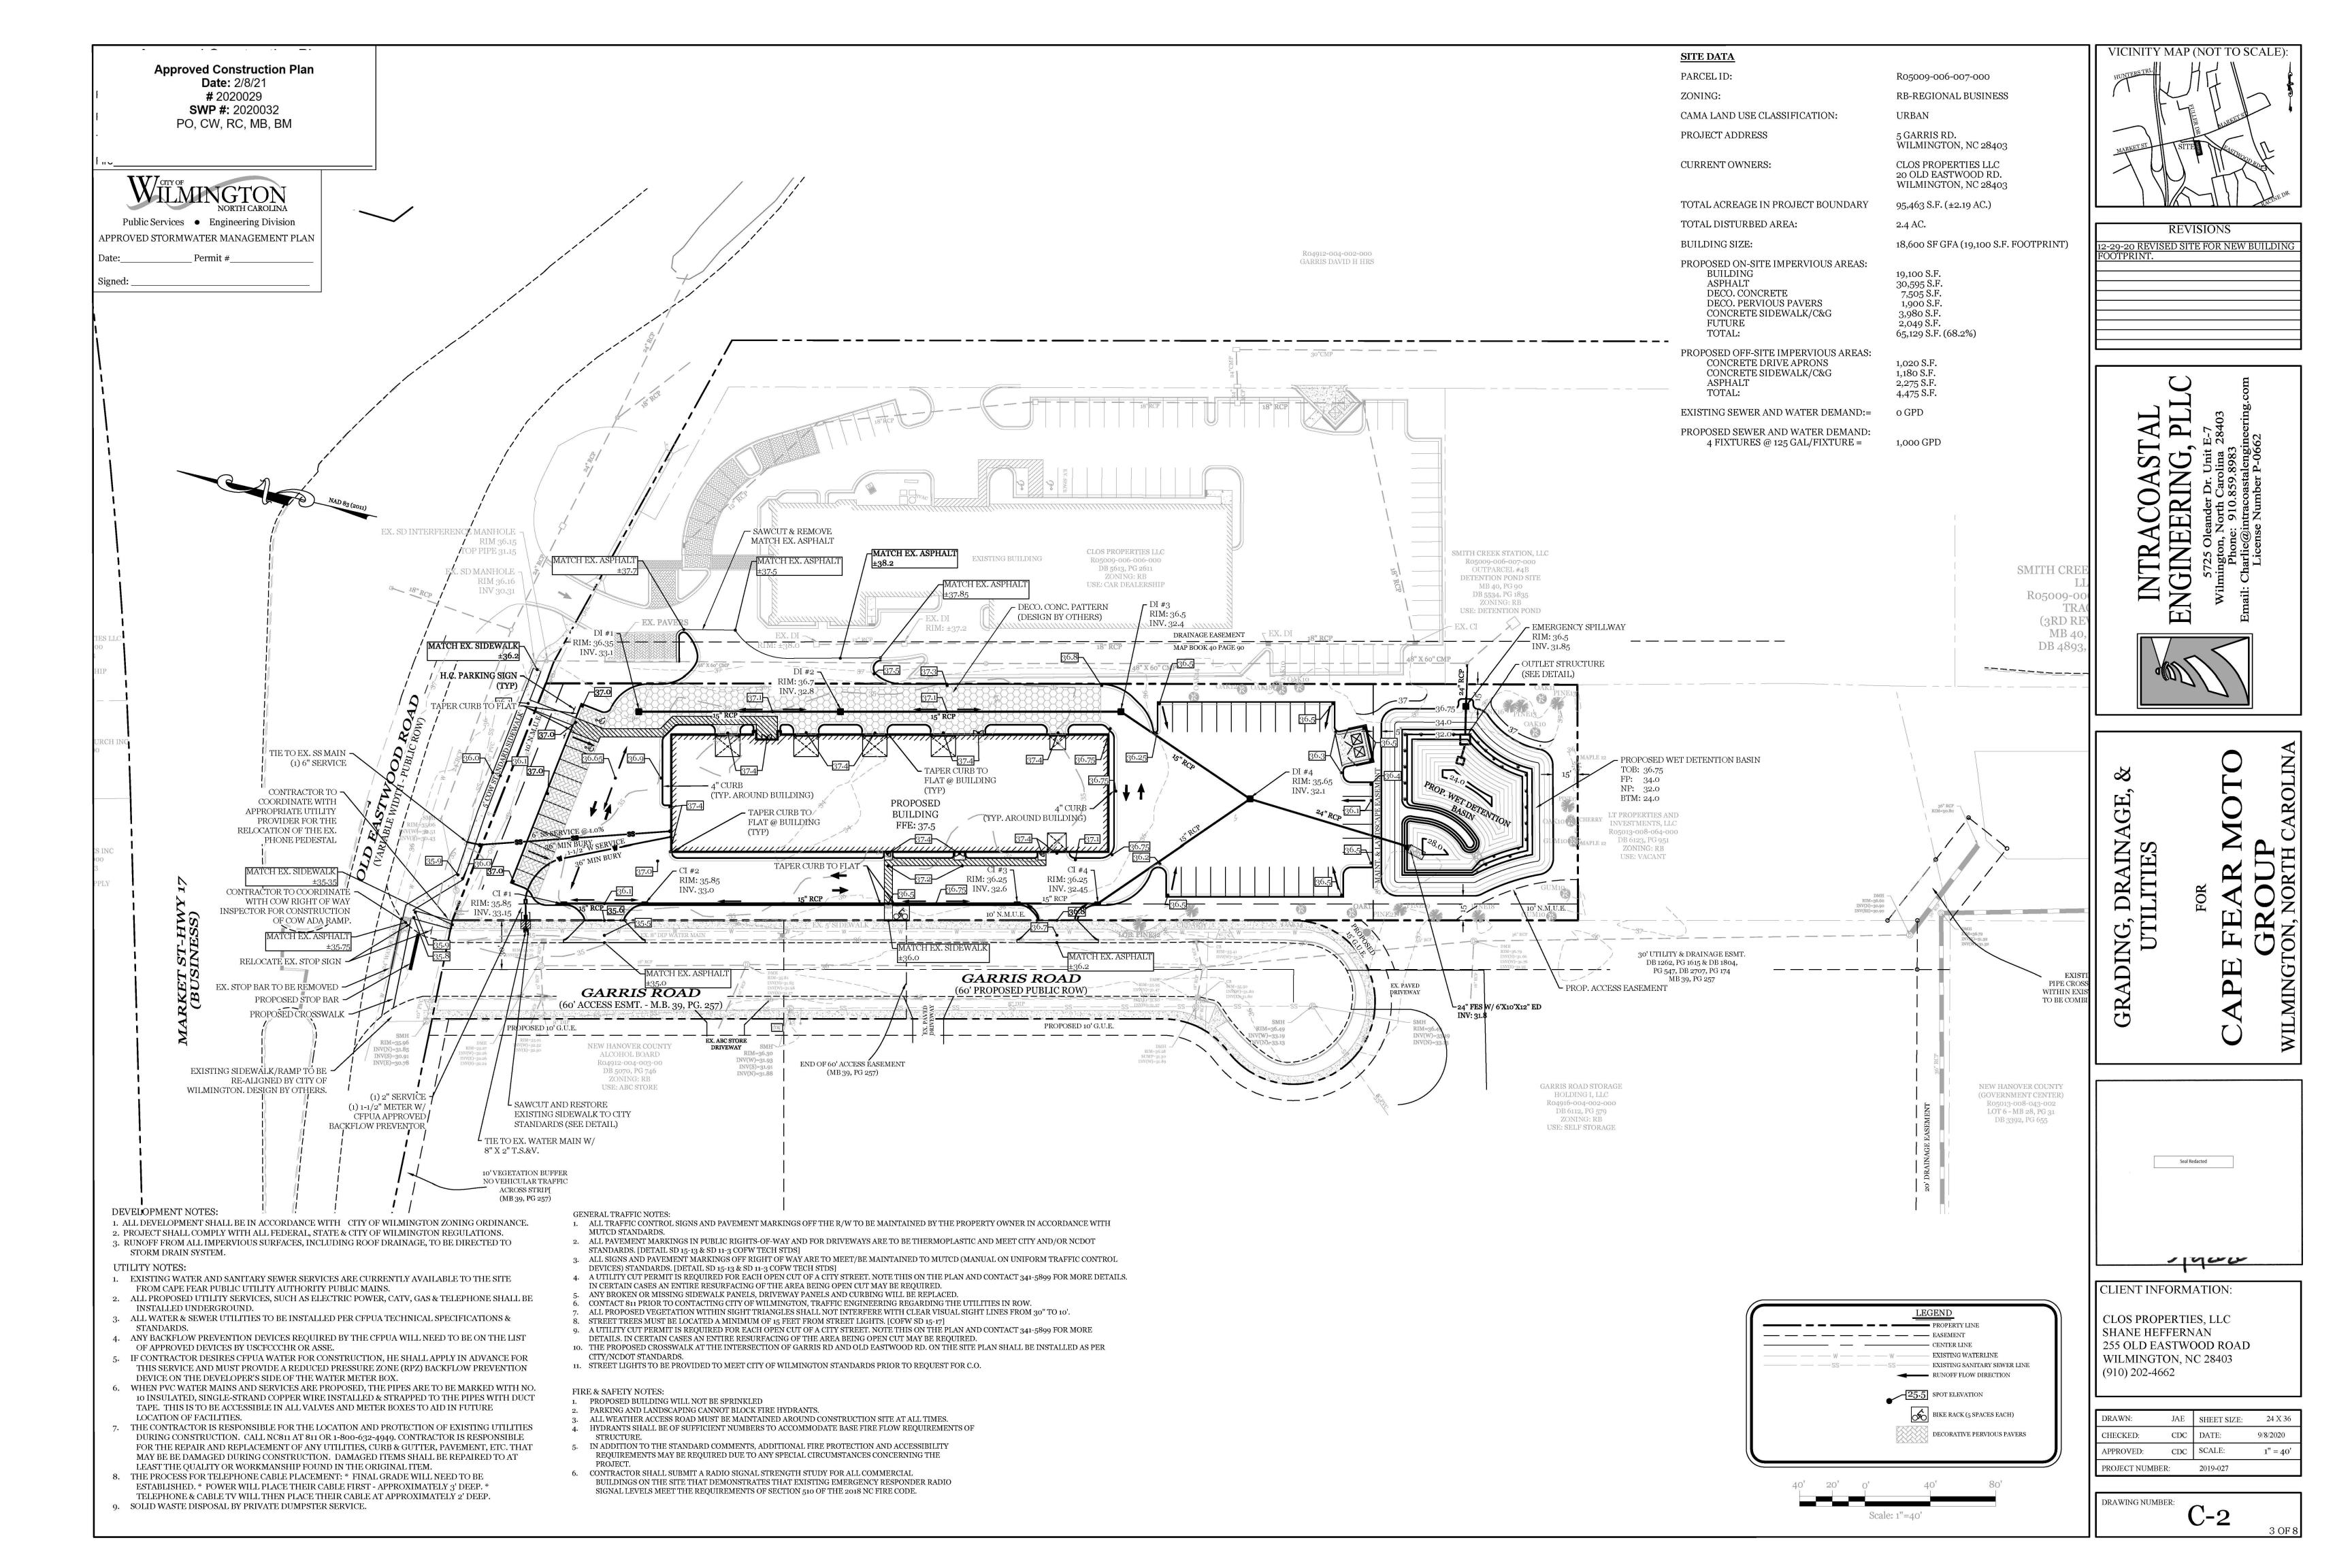

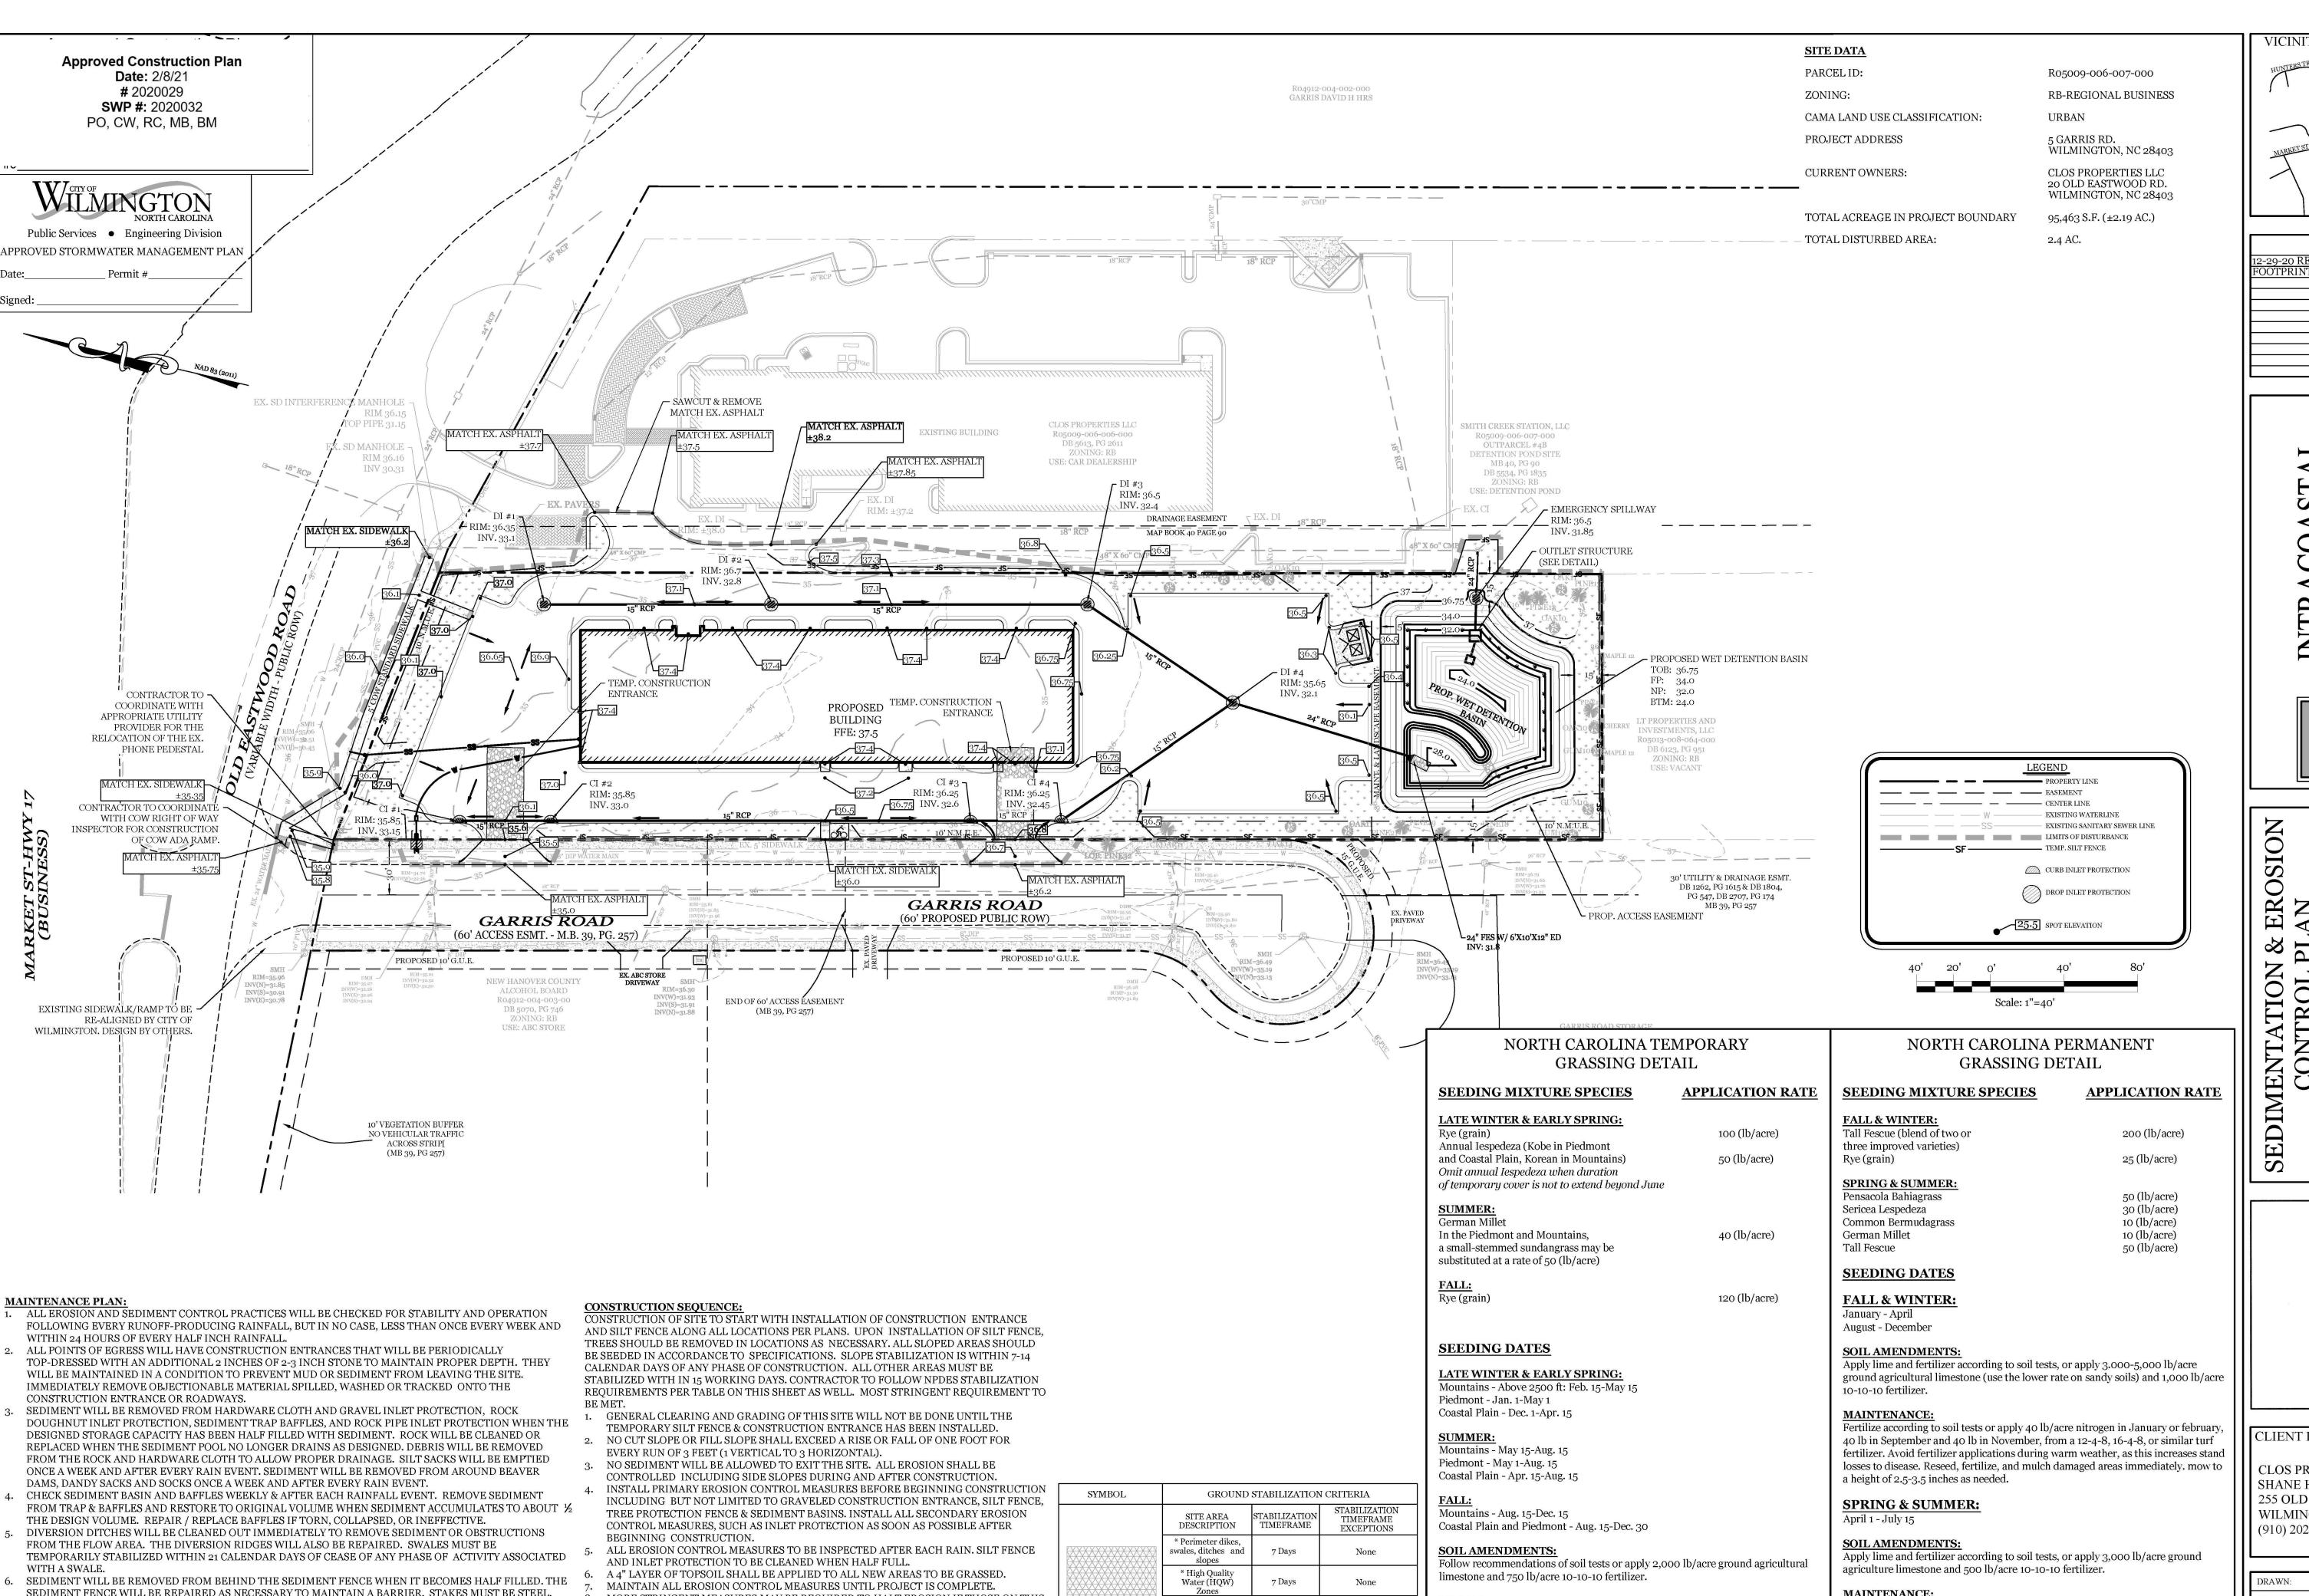

limestone and 750 lb/acre 10-10-10 fertilizer.

following erosion or other damage.

anchoring tool.

apply 4,000 lb/acre straw. anchor straw by tacking with asphalt, netting, or a

mulch anchoring tool. A disk with blades set nearly straight can be used as a mulch

Refertilize if growth is not fully adequate. reseed, refertilize and mulch immediately

7 Days

14 Days

Slopes 3:1 or flatter

\* All other areas with

slopes flatter than 4:1

less in length and

are not steeper than

2:1, 14 days are allowed

7-days for slopes

greater than 50 ft. in

perimeters & HQW Zones)

A 4" LAYER OF TOPSOIL SHALL BE APPLIED TO ALL NEW AREAS TO BE GRASSED.

REMOVE ALL TEMPORARY EROSION CONTROL MEASURES UPON COMPLETION OF

MORE STRINGENT MEASURES MAY BE REQUIRED TO HALT EROSION IF THOSE ON THIS

CONSTRUCTION. ALL PERMANENT MEASURES SHALL BE WELL ESTABLISHED PRIOR TO

MAINTAIN ALL EROSION CONTROL MEASURES UNTIL PROJECT IS COMPLETE.

PLAN PROVE TO BE LESS EFFECTIVE.

PROJECT COMPLETION.

SEDIMENT WILL BE REMOVED FROM BEHIND THE SEDIMENT FENCE WHEN IT BECOMES HALF FILLED. THE

BACKING. STAKE SPACING WILL BE 8 FEET MAX WHEN STANDARD STRENGTH FABRIC AND WIRE BACKING

ARE USED. IF ROCK FILTERS ARE DESIGNED AT LOW POINTS IN THE IN THE SEDIMENT FENCE THE ROCK

FAIRCLOTH SKIMMER TO BE ROUTINELY CHECKED FOR SEDIMENT ACCUMULATION, TRASH, AND DEBRIS

CLOGGING THE WATER ENTRY ORIFICES. PULL SKIMMER TO SIDE OF BASIN AND HAND REMOVE SEDIMENT

SEDIMENT FENCE WILL BE REPAIRED AS NECESSARY TO MAINTAIN A BARRIER. STAKES MUST BE STEEL.

STAKE SPACING WILL BE 6 FEET MAX. WITH THE USE OF EXTRA STRENGTH FABRIC, WITHOUT WIRE

WILL BE REPAIRED OR REPLACED IF IT BECOMES HALF FULL OF SEDIMENT, NO LONGER DRAINS AS

AND DEBRIS TO RESTORE FLOW TO ORIGINAL STATE.

VICINITY MAP (NOT TO SCALE):

REVISIONS -29-20 REVISED SITE FOR NEW BUILDIN



Seal Redacted 1900

CLIENT INFORMATION:

CLOS PROPERTIES, LLC SHANE HEFFERNAN 255 OLD EASTWOOD ROAD WILMINGTON, NC 28403 (910) 202-4662

DRAWN:	JAE	SHEET SIZE:	24 X 36
CHECKED:	CDC	DATE:	9/8/2020
APPROVED:	CDC	SCALE:	1" = 40'
PROJECT NUMBER:		2019-027	

DRAWING NUMBER

Refertilize the following april with 50 lb/acre nitrogen. Repeat as growth requires.


may be moved only once a year. Where a neat appearance is desired, omit sericea


apply 4,000 lb/acre straw. anchor straw by tacking with asphalt, netting, or a

mulch anchoring tool. A disk with blades set nearly straight can be used as a mulch

and mow as often as needed.

anchoring tool.

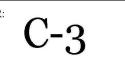

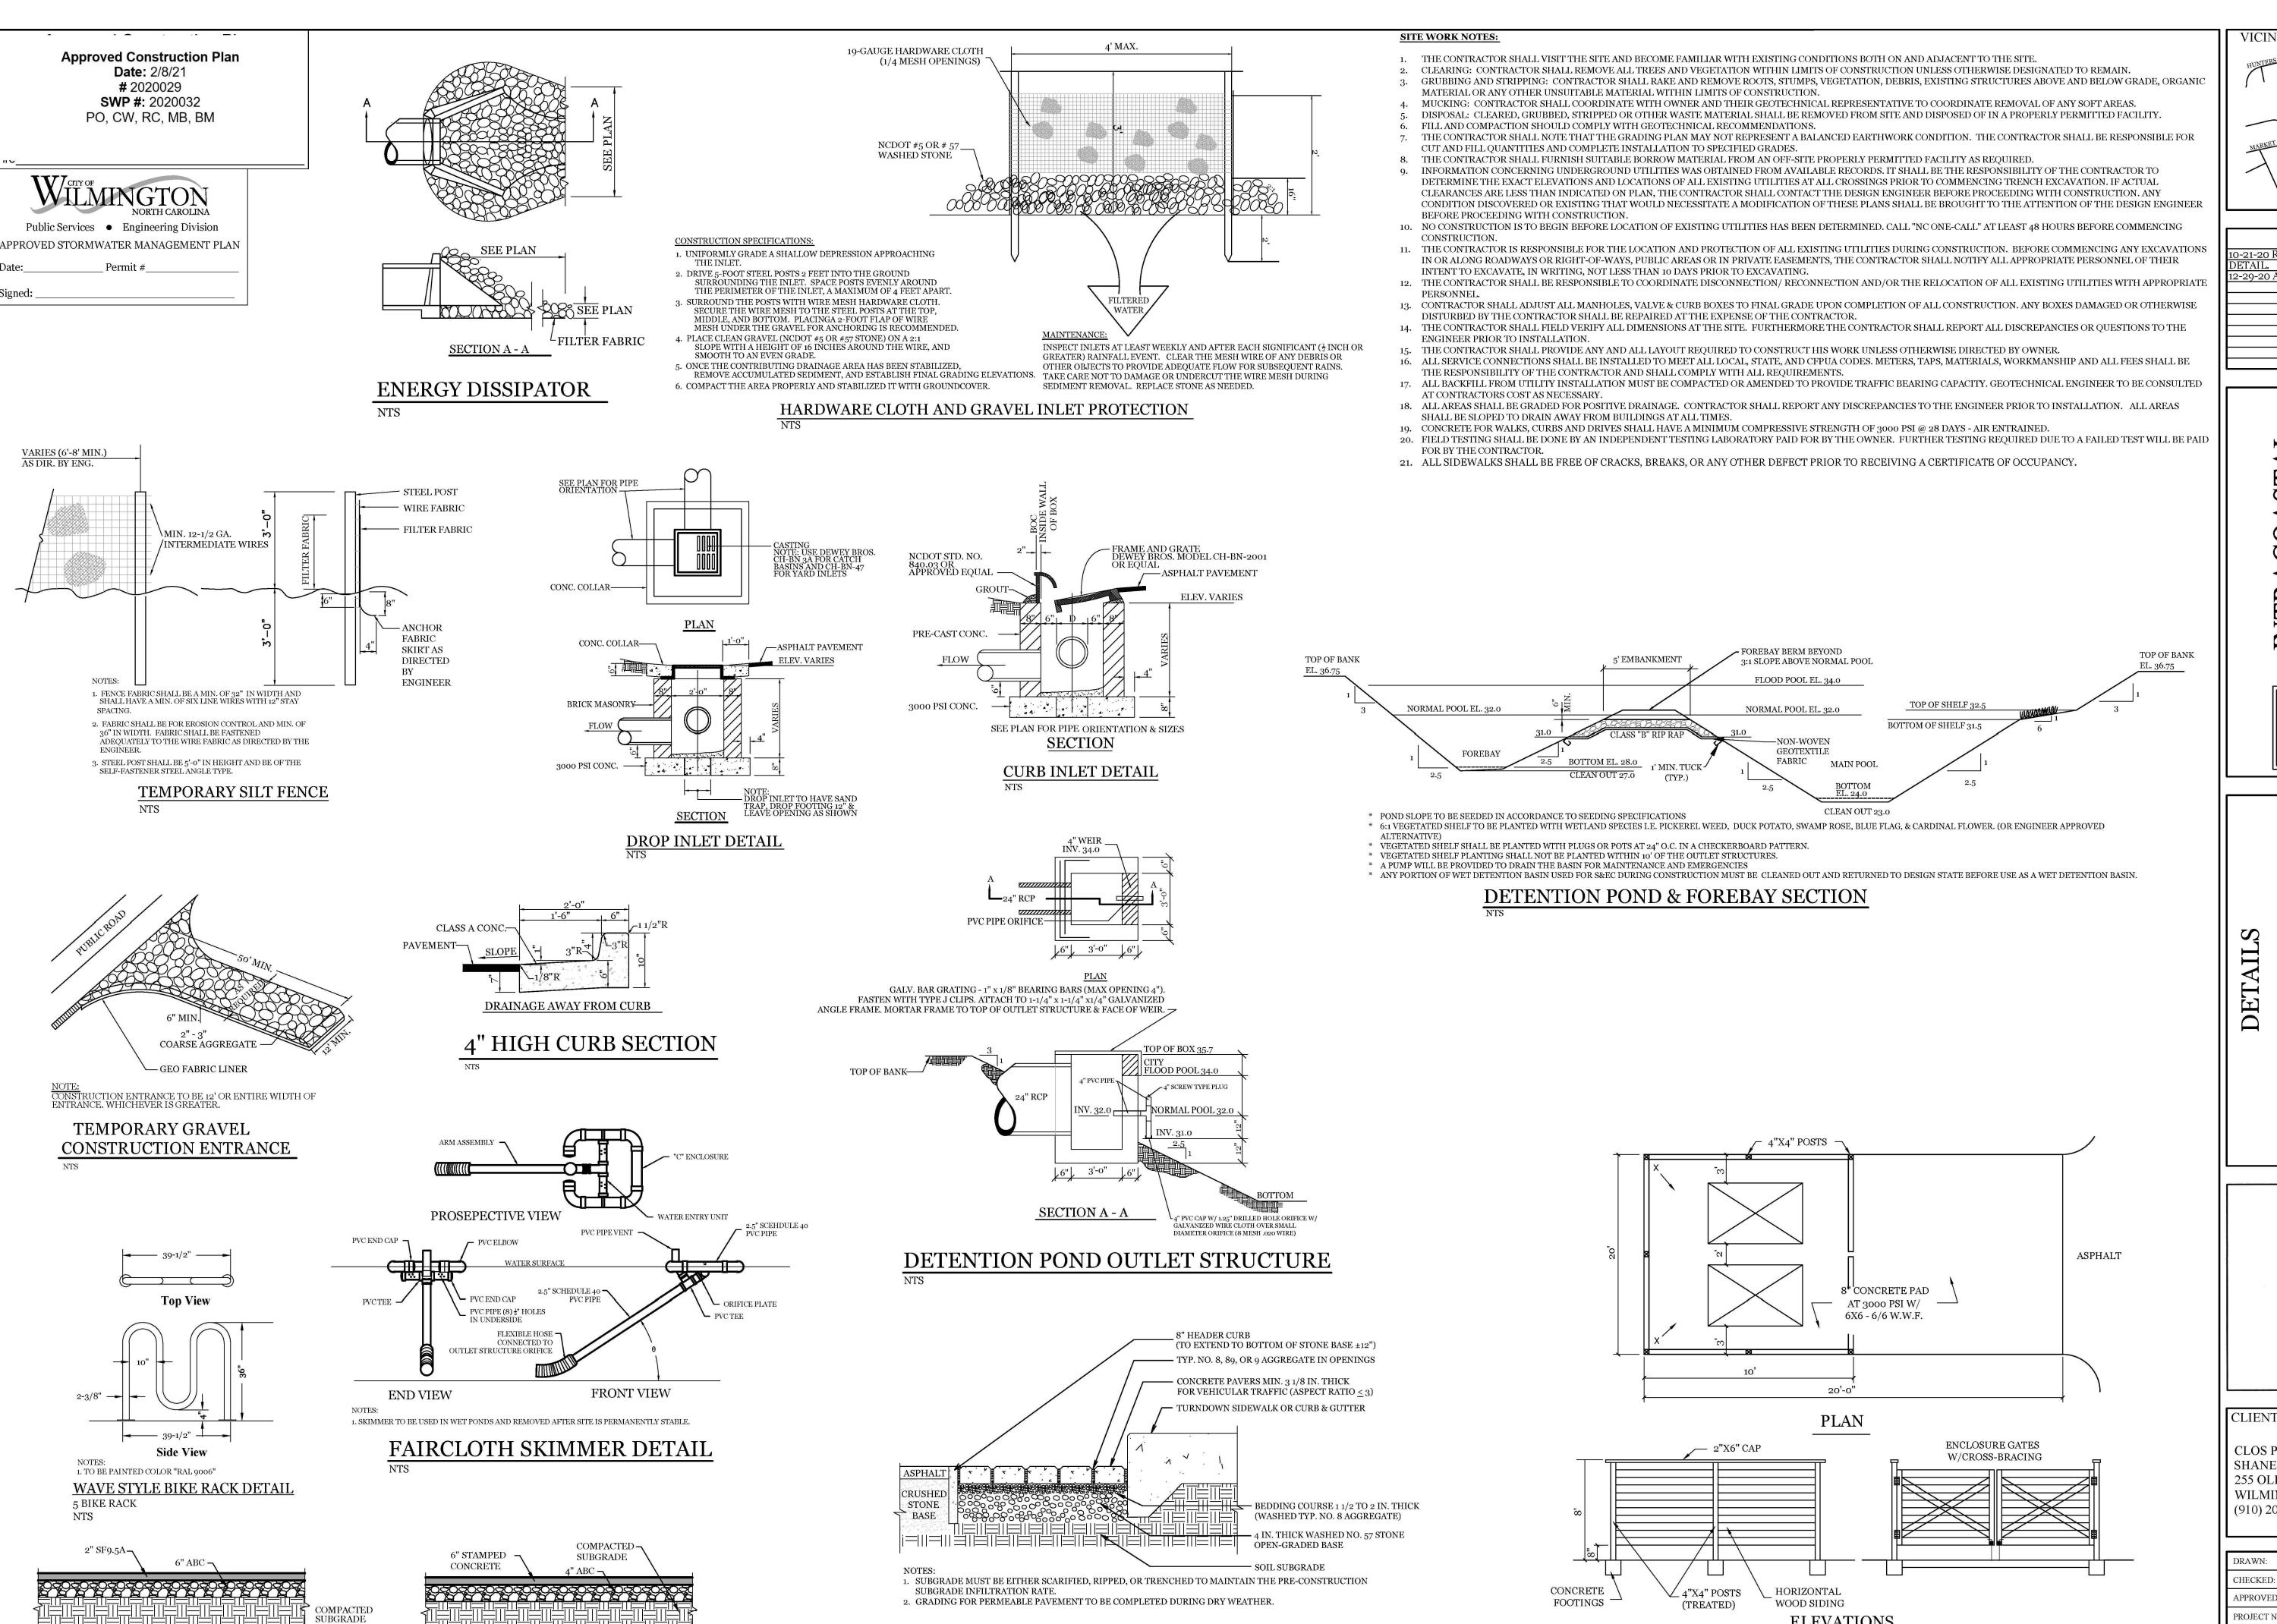



PERMEABLE PAVER SECTION

PARKING ASPHALT SECTION

DECORATIVE CONCRETE SECTION

REVISIONS -21-20 REVISED OUTLET STRUCTU

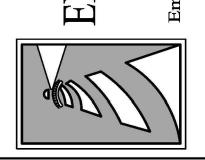

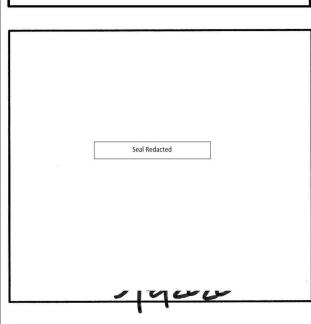

**CLIENT INFORMATION** 

CLOS PROPERTIES, LLC SHANE HEFFERNAN 255 OLD EASTWOOD ROAD WILMINGTON, NC 28403 (910) 202-4662


DRAWN:	JAE	SHEET SIZE:	24 X 36
CHECKED:	CDC	DATE:	9/8/2020
APPROVED:	CDC	SCALE:	NTS
PROJECT NUMBER:		2019-027	

DRAWING NUMBER:

**ELEVATIONS** 

**DUMPSTER PAD & ENCLOSURE DETAIL** 

C-4

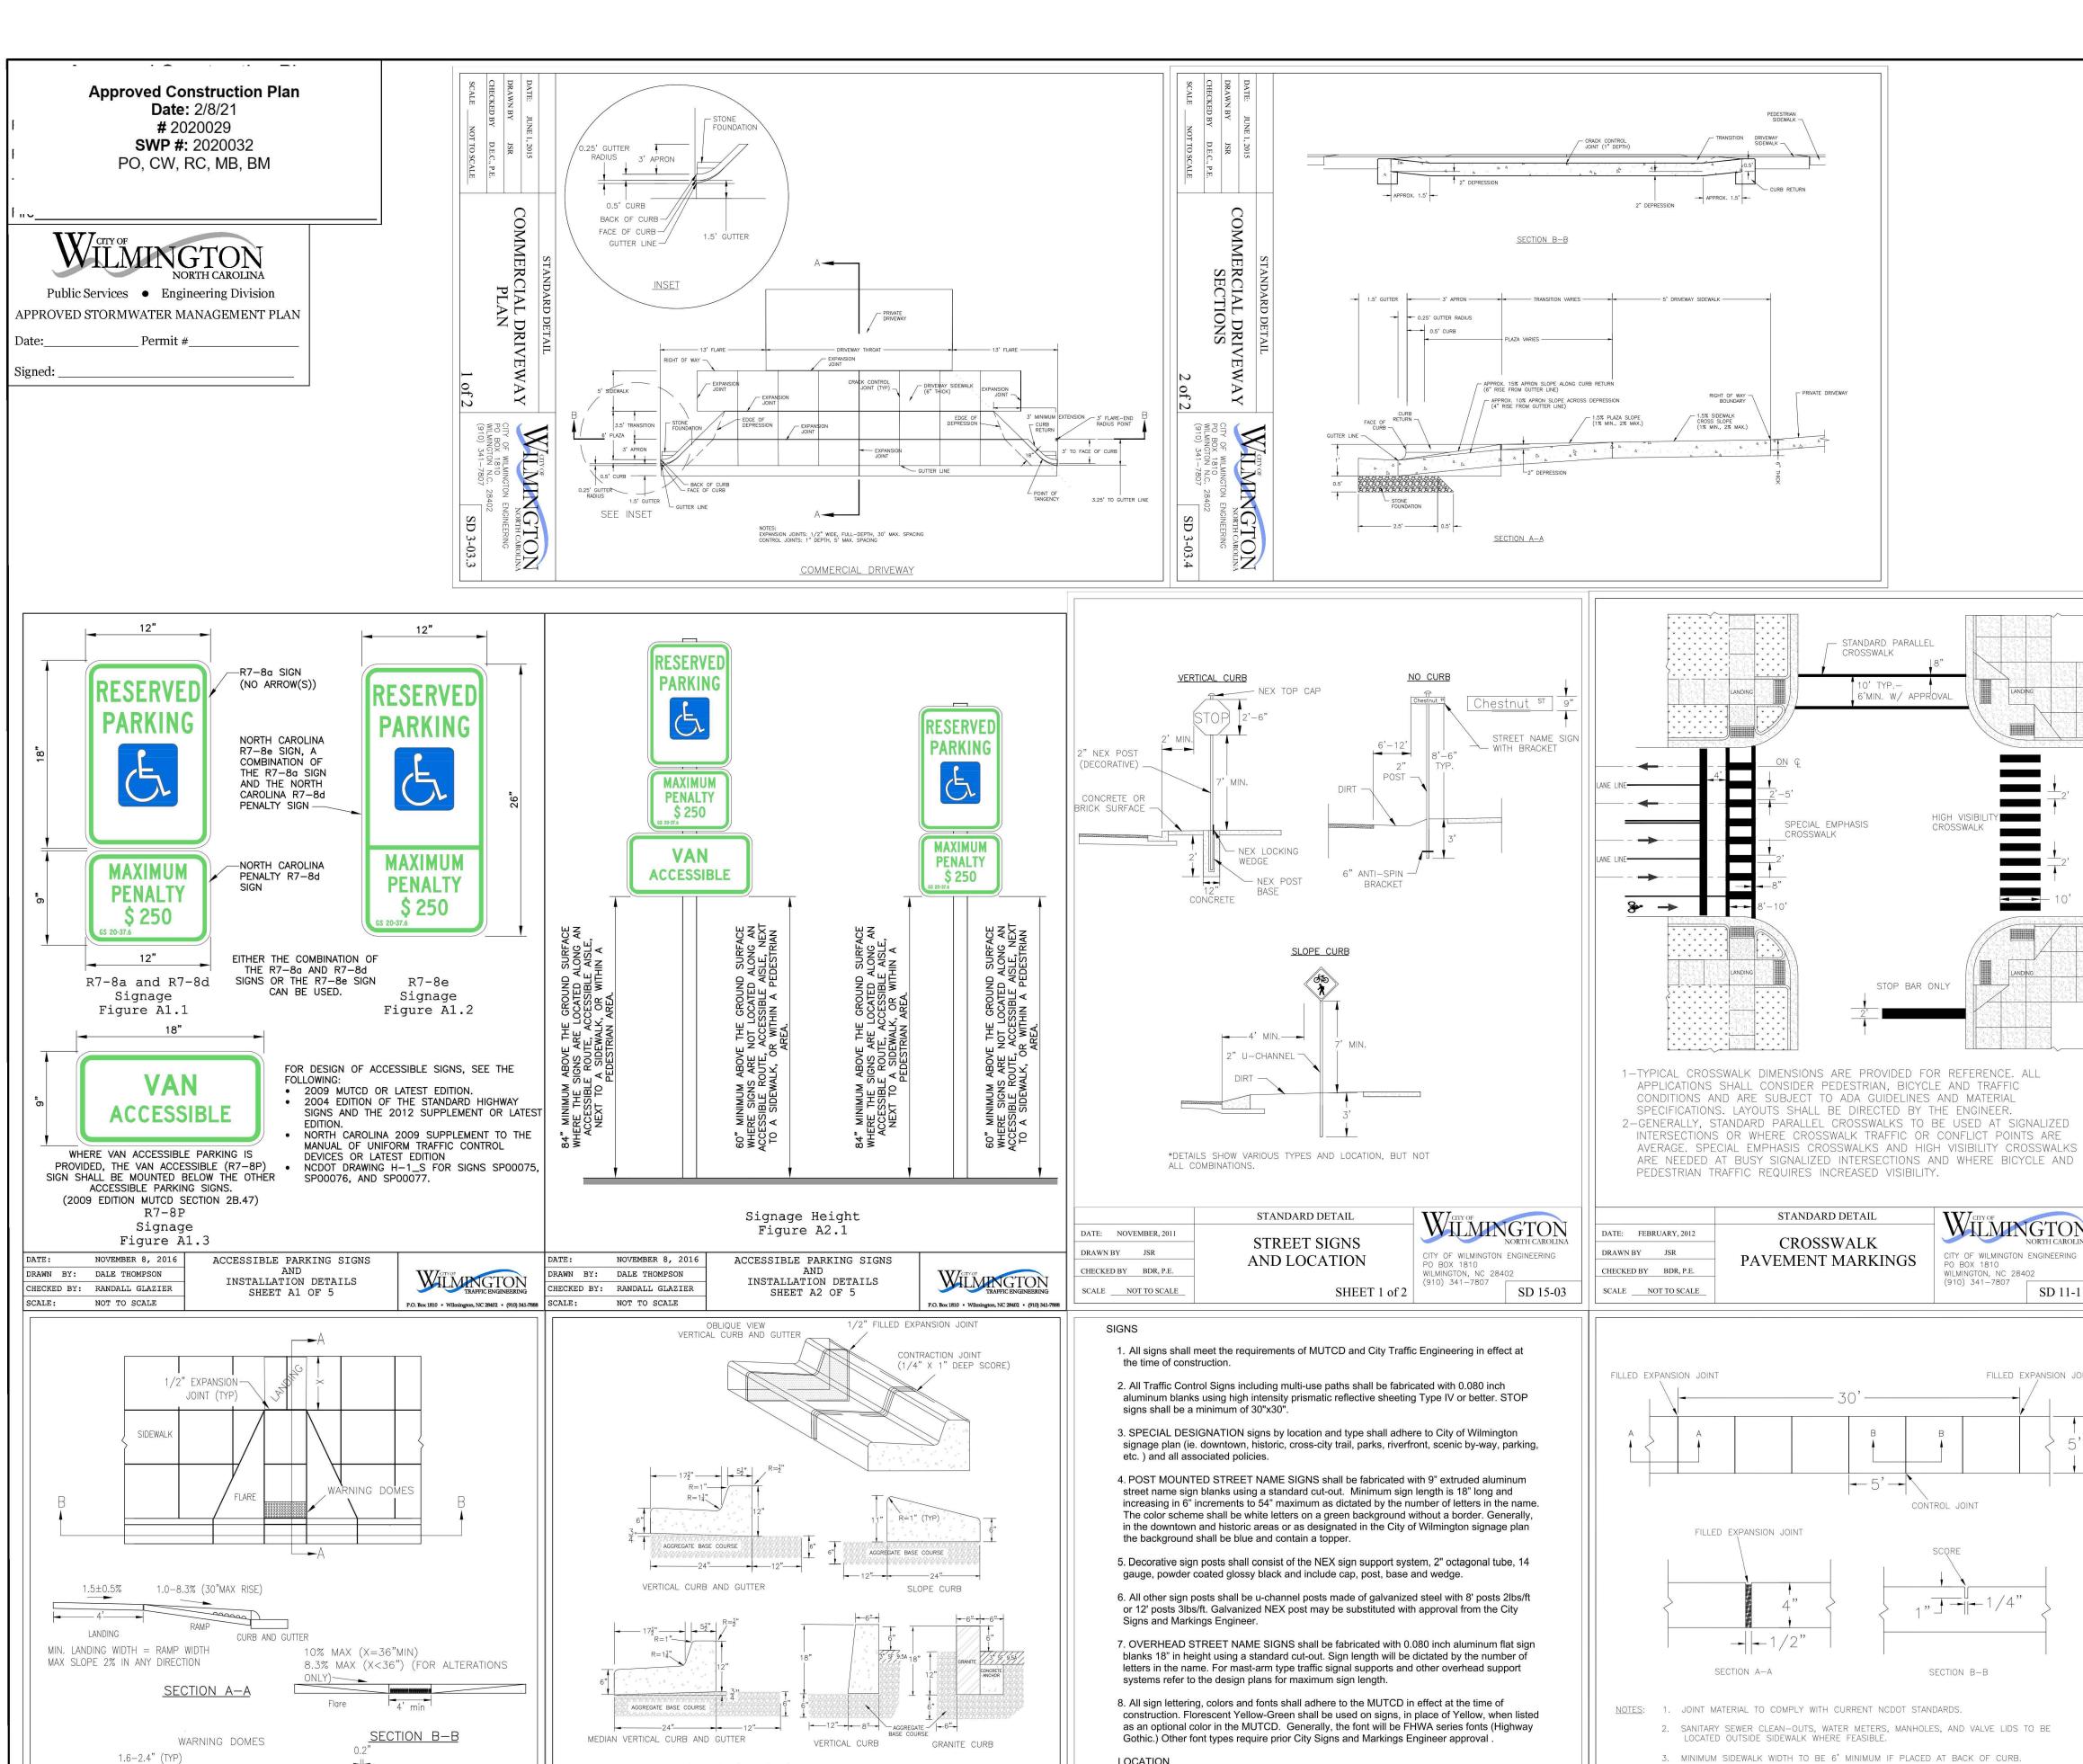

AGGREGATE BASE COURSE

HEADER CURB

TRUNCATED DOMES

OF BASE (TYP)

CITY OF WILMINGTON ENGINEERING

SD 3-07

1.6-2.4" (TYP)

DATE: DECEMBER, 2010

CHECKED: DEC

SCALE NOT TO SCALE

PB/JSR

DRAWN:

RAMP WIDTH

WARNING DOME NOTES: 1. USE CONTRASTING COLORS, RED OR BLACK ON WHITE PAVEMENT.

STANDARD DETAIL

PERPENDICULAR CURB

ADJACENT TO WALKING

**RAMP** 

3. RUBBER MATS ARE PERMITTED FOR RETROFITS.

2. USE CAST IN PLACE PAVERS FOR NEW CONSTRUCTION.

4. LANDING AND RAMP WIDTH MAY BE REDUCED TO 3' WHERE SPACE

IS LIMITED AND DESIGN IS APPROVED BY THE CITY ENGINEER.

BASE DIAMETER 0.9-1.4 TOP DIAMETER 50-60%

DRAWN: PB/JSR

CHECKED: DEC

SCALE NOT TO SCALE

AGGREGATE BASE COURSE

VALLEY CURB


NOTES: 1. EXPANSION JOINT MATERIAL TO COMPLY WITH CURRENT NCDOT STANDARDS


STANDARD DETAIL

**CURBING** 

2. 50' MAX EXPANSION JOINT SPACING, 10' MAX CONTRACTION JOINT SPACING

4. CONCRETE TO BE 3000 PSI MIN 5. VERTICAL CURB AND GUTTER BASE CAN BE SLOPED 3/4" OR USE A FLAT BASE

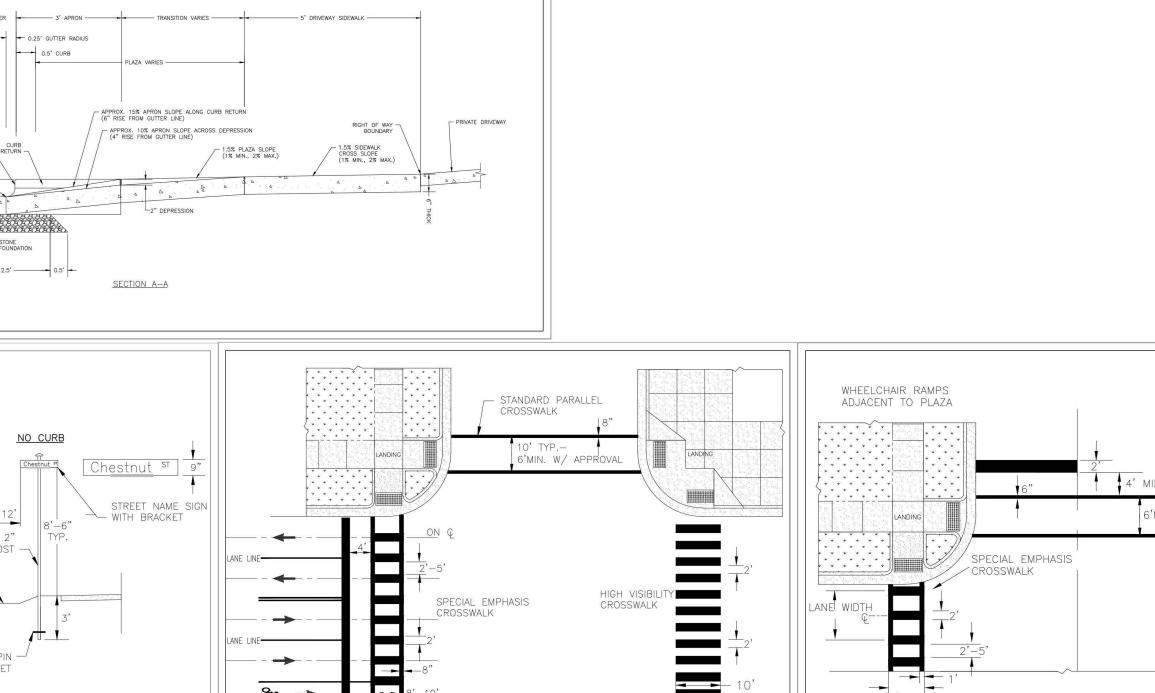

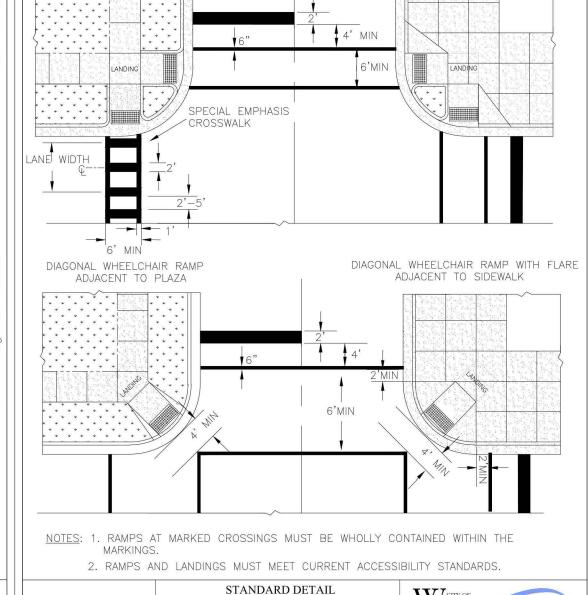

DRAWN:

CITY OF WILMINGTON ENGINEERING

SD 11-11

FILLED EXPANSION JOINT

PO BOX 1810

CONTROL JOINT

SECTION B-B

WILMINGTON NO PUBLICAROLIN

SD 3-10

CITY OF WILMINGTON ENGINEERING

4. CONCRETE FOR ALL SIDEWALKS (EXCEPT ANY PORTION CONTAIN WITHIN A DRIVEWAY APRON) SHALL BE CLASS "A" - 3,000 PSI.

9. MIN GRADE FOR PROPER DRAINAGE IS 1% IN AT LEAST 1 DIRECTION. MAX CROSS

SLOPE IS 2%. MAX LONGITUDINAL SLOPE IS 8.3%, 10% IF LIMITED BY EXISTING CONDITIONS, OR NO GREATER THAN

5. MINIMUM REPLACEMENT FOR REPAIRS IS A 5' X 5' PANEL

7. MINIMUM DEPTH FOR TUNNELING BELOW SIDEWALK IS 12"

8. MAX ADJACENT GROUND SLOPE WITHOUT RAILING IS 2:1

THE SLOPE OF THE EXISTING ADJACENT ROAD.

DATE: OCTOBER, 2010

SCALE NOT TO SCALE

DRAWN: PB/JSR

CHECKED: DEC

CITY OF WILMINGTON ENGINEERING

SD 15-03

WILMINGTON, NC 28402

6. 4" STONE BASE MAY BE REQUIRED FOR POOR SOIL CONDITIONS

STANDARD DETAIL

**SIDEWALK** 

9. Sign locations depend on the edge of road condition. Generally, signs shall be a minimum

2' from face of a vertical curb, 4' from front of slope face curb, and 6' from edge of pavement

10. Sign posts installed in dirt shall be buried a minimum of 36". Octagonal posts shall utilize

11. Street name signs shall be installed 8'-6" from the ground to the bottom of the sign. Street

name signs co-located with STOP signs shall be installed above the STOP sign. A 6" space

STOP sign face. All other signs should be mounted per MUTCD guidelines for Urban Areas.

SHEET 2 of 2

shall be maintained between the STOP sign and a Street name sign that is parallel to the

STANDARD DETAIL

STREET SIGNS

AND LOCATION

an anti-spin device, 6" in length minimum. Sign posts installed in concrete or brick shall

without curb. Signs shall not be located more than 12' from any of these locations.

utilize a base cast in concrete 24" x 12" diameter.


DATE: NOVEMBER, 2011

CHECKED BY BDR, P.E.

SCALE NOT TO SCALE

DRAWN BY JSR

SD 3-11

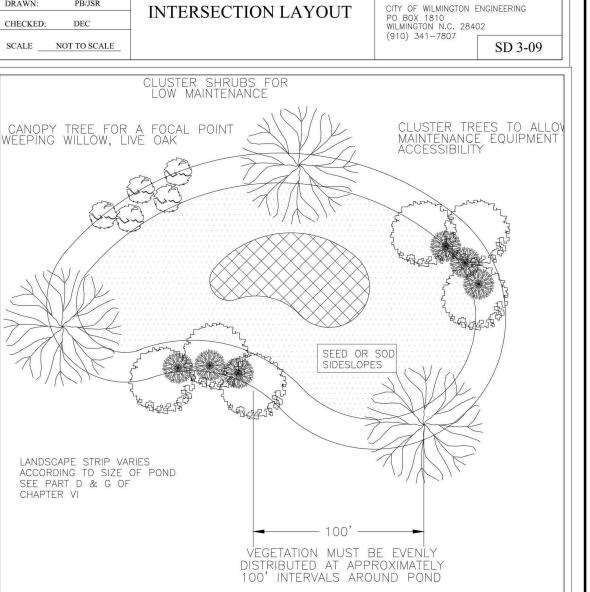

If possible, locate pond where vegetation exists.

Landscape strip shall be a maximum slope of

Provide a minimum of 3 inches of mulch around

STANDARD DETAIL

**TYPICAL** 

STORM WATER FACILITY

LANDSCAPING PLAN

WILMINGTON

SD 15-16

PO BOX 1810

WILMINGTON, NC 28402 (910) 341-7807

2. Suggest minimal clearing to conserve visual

of tree planting. An irregular shape

provides a more natural appearance.

7:1 in order to plant vegetation.

all vegetation.


DATE: JULY 2003

DRAWN BY JSR

CHECKED BY B.P., P.E.

SCALE NOT TO SCALE

quality of site and minimize the additional

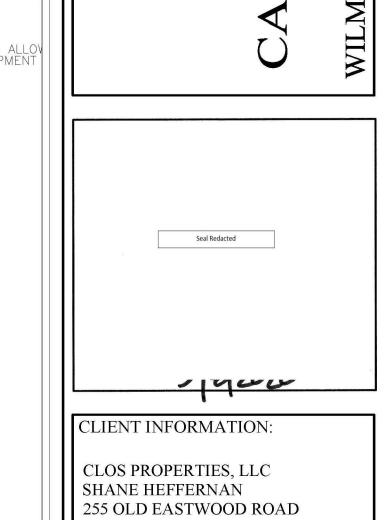

DETAI

VICINITY MAP (NOT TO SCALE):

REVISIONS

PL

INTRACOAS INGINEERIN

H

V

WHEELCHAIR RAMPS WITH FLARE


ADJACENT TO SIDEWALK

WILMINGTON, NC 28403


DRAWN:	JAE	SHEET SIZE:	24 X 36
CHECKED:	CDC	DATE:	9/8/2020
APPROVED:	CDC	SCALE:	NTS
PROJECT NUMB	ER:	2019-027	

DRAWING NUMBER


(910) 202-4662

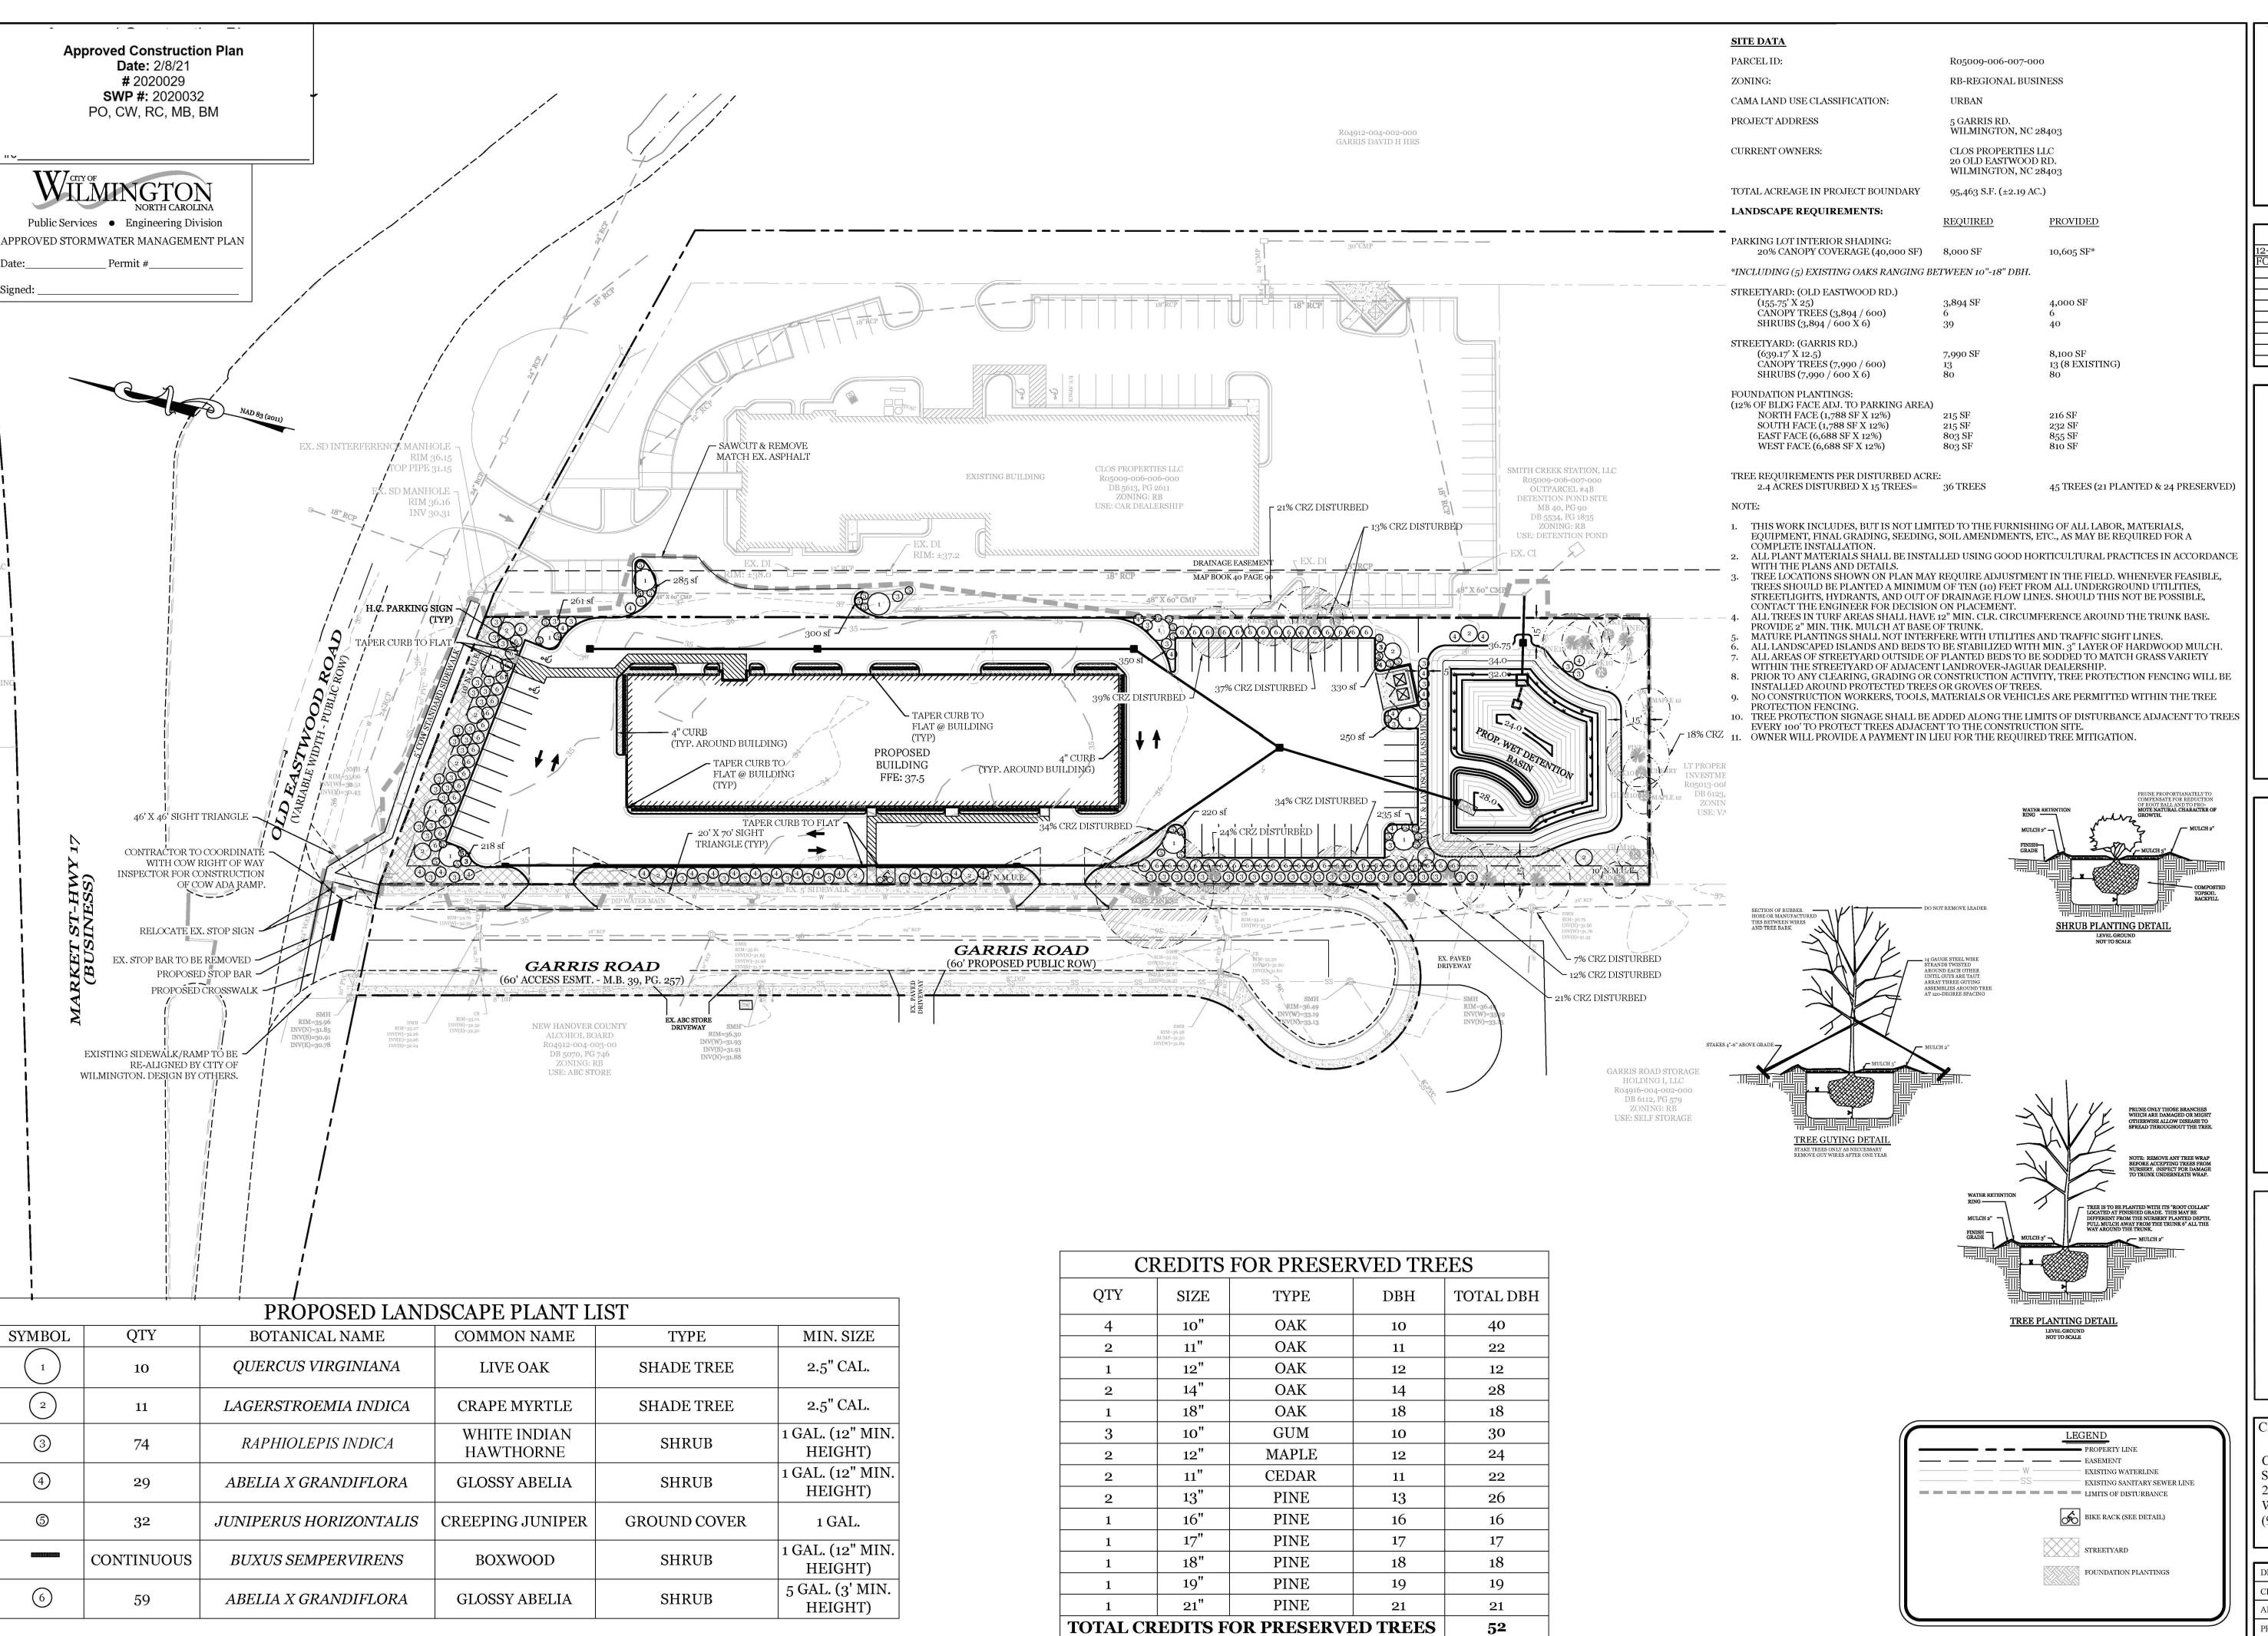


205 TREES REQUIRED FOR MITIGATION - 52 TREE CREDITS = 153 TREES REQUIRED FOR MITIGATION

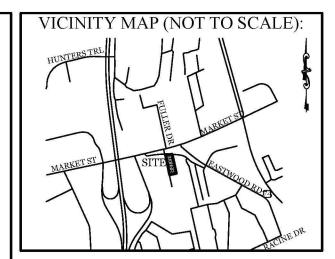

REVISIONS 2-29-20 REVISED SITE FOR NEW BUILDING

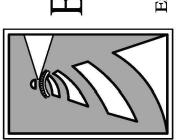

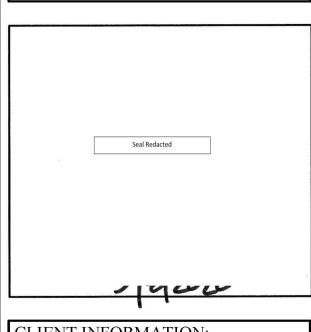

CLIENT INFORMATION

CLOS PROPERTIES, LLC SHANE HEFFERNAN 255 OLD EASTWOOD ROAD WILMINGTON, NC 28403 (910) 202-4662

Scale: 1"=40'

DRAWN:	JAE	SHEET SIZE:	24 X 36
CHECKED:	CDC	DATE:	9/8/2020
APPROVED:	CDC	SCALE:	1" = 40'
PROJECT NUMBER:		2019-027	

DRAWING NUMBER: L-1